# STORMWATER MANAGEMENT PLAN

# 105 ERNEST STREET LAKEMBA



Con Katsoulas
BE (Civil), MIEAust, CPEng No. 449924

SHEET INDEX:

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<u>LEGEND</u>	
FLOWPATH	IL 0.00 PIT/PIPE INVERT LEVEL
	TK 0.00 TOP OF KERB LEVEL
PROPOSED GRATED PIT	+ 00.00 EXISTING SURFACE LEVEL + 00.00 PROPOSED SURFACE LEVEL
PROPOSED SEALED WATER TIGHT PIT RAINHEAD	• IP SEALED INSPECTION OPENING
SUMP OVERFLOW PROPOSED STORMWATER PIPE - GRAVITY	DP-1 DOWNPIPE - TYPE 1  HIP ROOF
)) - PROPOSED V-DRAIN	FLAT ROOF
PROPOSED STORMWATER PIPE - CHARGED PROPOSED RISING MAIN (PRESSURE PIPE)	TERRACE/BALCONY
PROPOSED SUBSOIL DRAIN PROPOSED BUILDING - GROUND FLOOR	BASIX ROOF AREA DRAINING TO RAINWATER TANK
<ul><li>— PROPOSED BUILDING - FIRST FLOOR</li><li>— PROPOSED CONTOURS</li></ul>	AREA BYPASSING ON-SITE DETENTION TANK

#### NOTES

- ALL PROPOSED PITS TO BE 450 x 450 CAST IN-SITU OR
   PRECAST PITS UNLESS SHOWN OTHERWISE.
- 2. ALL CHARGED LINE PIPES TO BE 100Ø uPVC SEWER CLASS UNI ESS SHOWN OTHERWISE
- 3. ALL DOWNPIPES TO BE 900 uPVC OR 100 x 50 UNLESS OTHERWISE SHOWN
- 4. ALL NON-PRESSURE STORMWATER PIPES TO BE 100Ø uPVC UNLESS SHOWN OTHERWISE
- 5. ALL GRATED DRAINS TO BE MINIMUM 150 WIDE GALVANIZED HEAVY DUTY GRATES
- 6. ALL NON-TRAFFICABLE PITS TO BE LIGHT DUTY. PITS IN TRAFFICABLE AREAS TO BE HEAVY DUTY.
- ALL WORK SHALL BE CARRIED OUT IN ACCORDANCE WITH COUNCILS SPECIFICATIONS.
- ALL PITS GREATER THAN 1.2m DEPTH SHALL INCLUDE STEP IRONS AND HAVE MINIMUM CLEAR DIMENSIONS OF 600 x 600.
- ALL PITS ARE TO BE BENCHED TO ALLOW SMOOTH FLOW OF WATER THROUGH PITS
- ALL DOWNPIPES SHALL CONFORM TO AS/NZS 1866 FOR ALUMINIUM PIPES AND AS 1254, AS/NZS 1260, AS 1273, AS/NZS 1477, AS/NZS 2179.2 AND AS 2032 FOR uPVC PIPES.
- 11. ALL BOX GUTTERS SHALL COMPLY WITH AS/NZS 2179.112. ALL BOX GUTTERS SHALL BE CONSTRUCTED WITH A
- MINIMUM 1:200 GRADE TO SUMP/DOWNPIPES
  13. ALL DRAINAGE WORKS SHALL BE IN ACCORDANCE WITH


DOWNPIPE TYPE	DOWNPIPE SIZES					
DOWNFIPE I TPE	ROUND	RECTANGULAR				
1	90Ø	100 X 75				
2	100Ø	100 X 75				
3	125Ø	100 X 100				


150Ø

150 X 150


### FOR DA APPROVAL

SURVEYOR	0	DA ISSUE	17/04/21			C.K. ENGINEERING SERVICES	CLIENT:	DRAWING TITLE:	DRAWN:	M.P.	SIGNED:	M	DATE: FEBRUARY 2022
ORION SURVEYING	1	DA ISSUE - AMEND TO ARCHITECTS REVISION 15/12/21	19/01/22			ABN 67 115 216 496	NK ARCHITECT	INDEX	DESIGNED:	CK	1	hl	SCALE: AS SHOWN
ARCHITECT	2	DA ISSUE - PROVIDE BELOW GROUND TANK	18/02/22			49 FLORA ST						70 -	
N K ARCHITECT						ROSELANDS, NSW 2196	PROJECT:		CHECKED:	C.K.	,	1	DATUM: AHD
CONSULTANT	No.	AMMENDMENT	DATE No.	. AMMENDMENT	DATE	MOB: 0403 329 327	105 EARNEST STREET, LAKEMBA		JOB & DRAV	VING No:	212	066	No. IN SET:
-				DO NOT SCALE		EMAIL: ckatsoulas@gmail.com	, 1-11-11		JOB & DIVAV	VIIVO IVO.	212	00	1 OF 6 1550E: Z

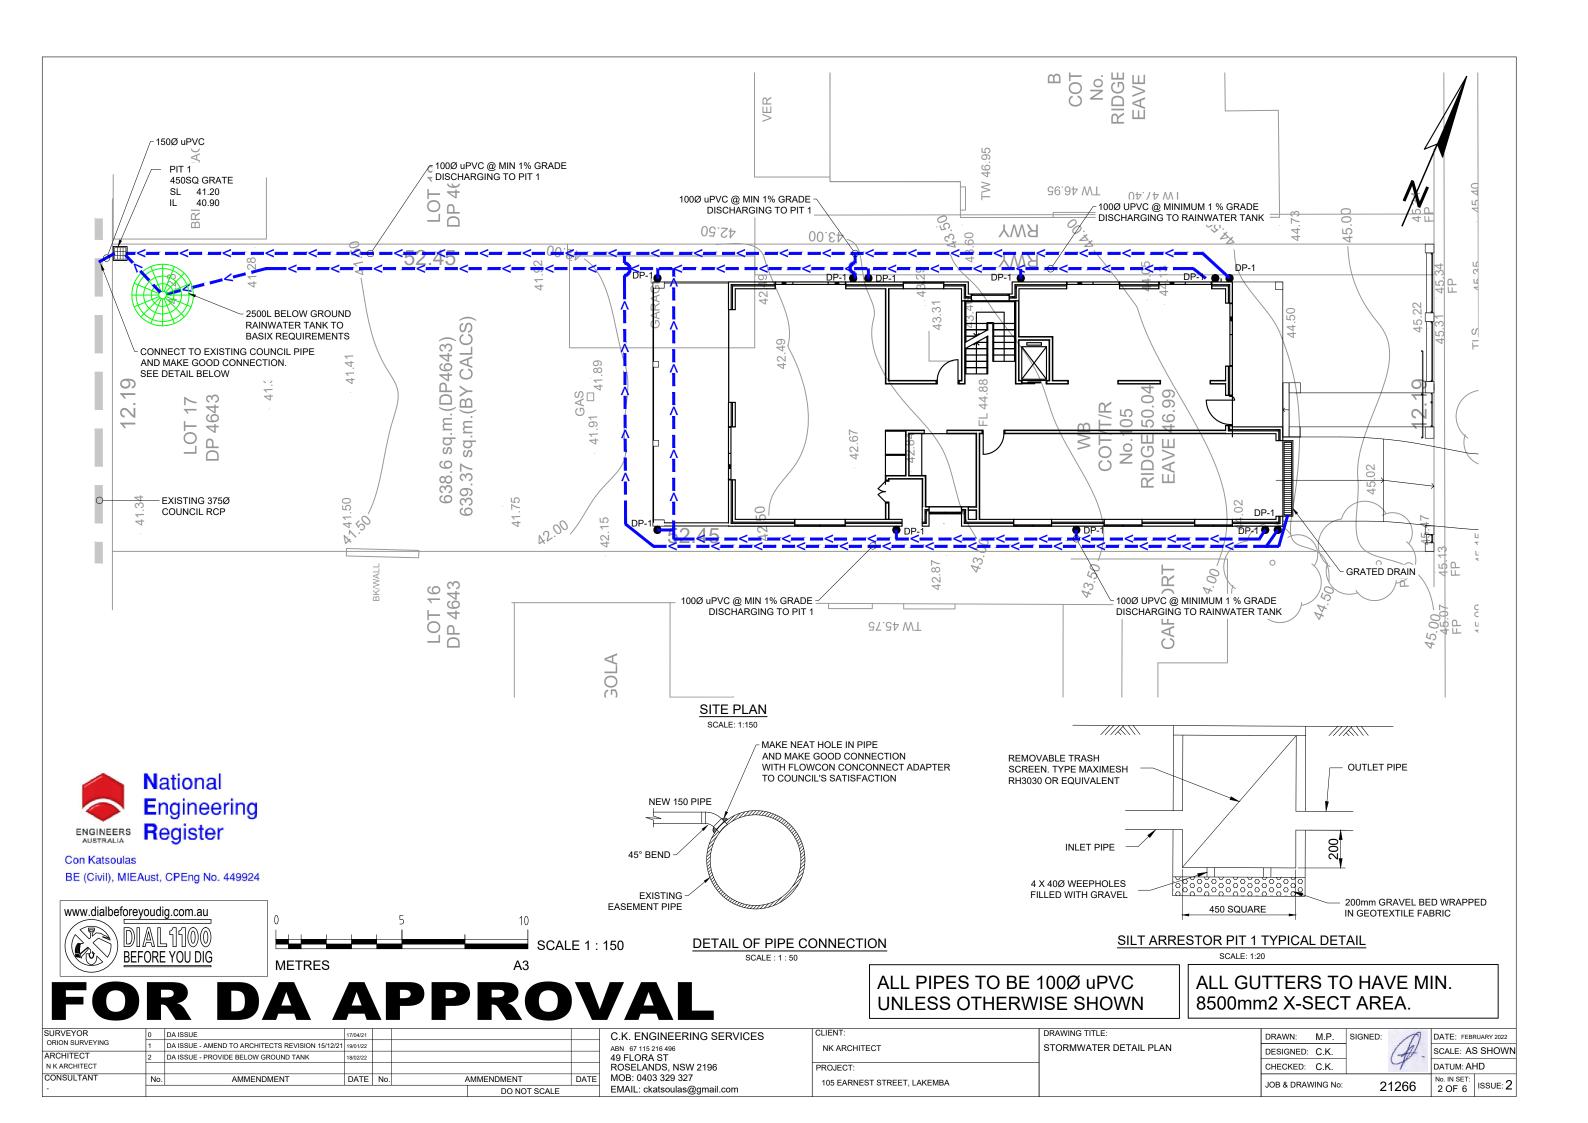

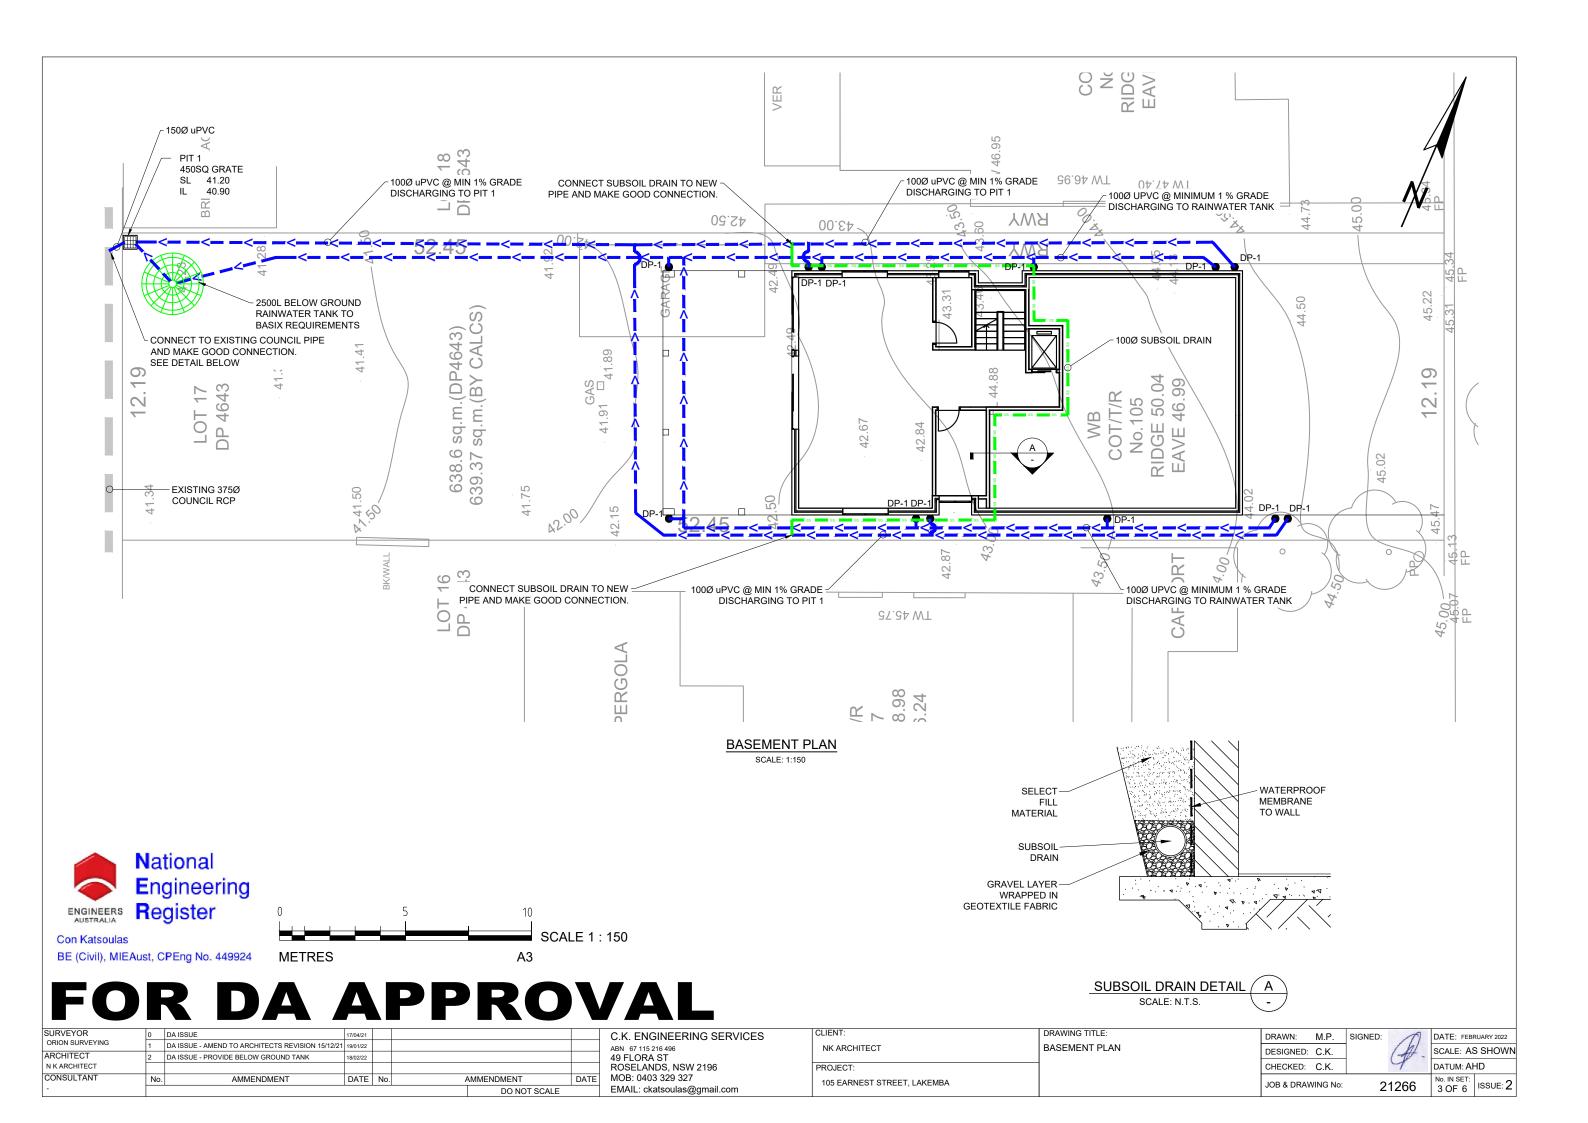



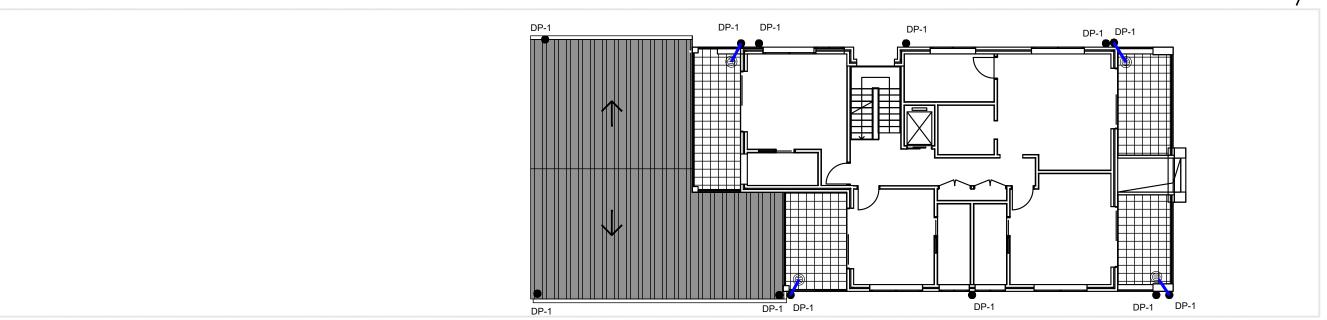

#### FIRST FLOOR PLAN






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N K ARCHITECT						ROSELANDS, NSW 2196	PROJECT:	1	CHECKED:	C.K.		7	DATUM: AHD
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-				DO NOT SCALE		EMAIL: ckatsoulas@gmail.com			JOB & DIV	WING NO.	21	1266	4 OF 6 ISSUE: 2



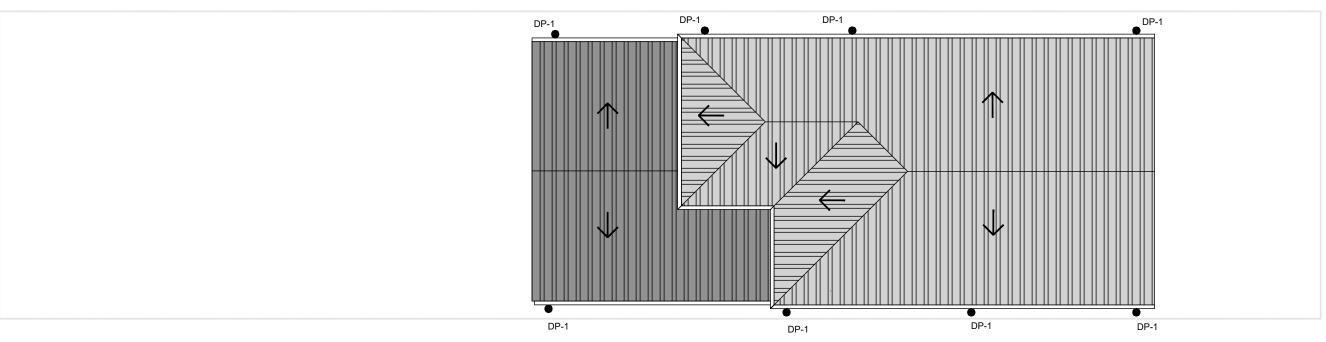

ROOF PLAN SCALE: 1:150



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C.K. ENGINEERING SERVICES

ABN 67 115 216 496

49 FLORA ST

ROSELANDS, NSW 2196

MOB: 0403 329 327

EMAIL: ckatsoulas@gmail.com


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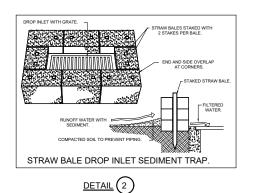
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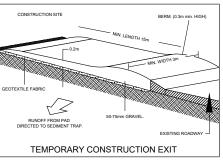
105 EARNEST STREET, LAKEMBA


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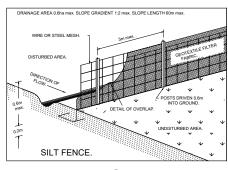
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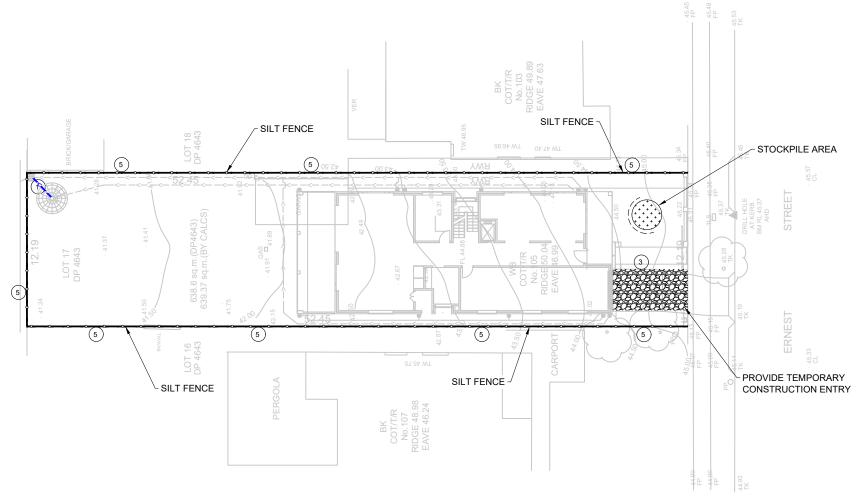




DETAIL (3)

DETAIL 4

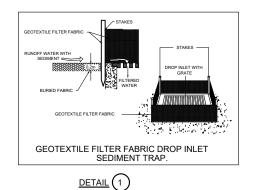DETAIL (5)

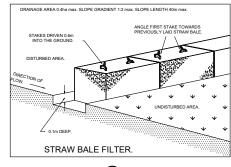

#### **EROSION CONTROL NOTES:**

- ALL WORK SHALL BE CARRIED OUT IN ACCORDANCE WITH COUNCIL'S STANDARD SPECIFICATIONS AND TO THE SATISFACTION OF COUNCIL'S ENGINEER.
- EROSION AND SEDIMENTATION CONTROLS SHALL BE CONSTRUCTED AS SHOWN ON SHEET 2 AND 3 OF THIS PLAN AND/OR WHERE DIRECTED BY COUNCIL'S ENGINEER.
- 3. SEDIMENTATION AND EROSION CONTROL DEVICES SHALL BE IMPLEMENTED PRIOR TO OR IN CONJUNCTION WITH THE FIRST PHASE OF EARTHWORKS AND SHALL BE REMOVED ONLY WHEN THE AREAS ABOVE IT HAVE BEEN STABILISED. EACH SEDIMENTATION AND EROSION CONTROL DEVICE SHALL BE INSPECTED AFTER EACH STORM FOR STRUCTURAL DAMAGE OR CLOGGING BY SILT AND OTHER DEBRIS AND PROMPTLY DESILTED, REPAIRED OR REPLACED IF REQUIRED.
- TOPSOIL STOCKPILES SHALL BE LOCATED OUTSIDE HAZARD AREAS SUCH AS DRAINAGE DEPRESSIONS.
- ALL AREAS NOT SUBJECT TO CONSTRUCTION WORKS SHALL BE RETAINED FREE FROM DISTURBANCE OR DAMAGE FOR THE DURATION OF THE WORKS.
- TREES TO BE RETAINED SHALL BE PROTECTED DURING SITE WORKS AND CONSTRUCTION BY THE ERECTION OF SOLID BARRICADES AT THE DRIP LINE OR AS SPECIFIED BY COUNCIL'S ENGINEER.
- THE DEVELOPER OR CONTRACTOR WILL TAKE ALL MEASURES TO PREVENT DAMAGE TO TREES AND ROOT SYSTEMS DURING SITE WORKS AND CONSTRUCTION ACTIVITIES INCLUDING THE PROVISION OF WATER, SEWERAGE AND STORMWATER DRAINAGE SERVICES. IN PARTICULAR, WORKS, ERECTION OF STRUCTURES, EXCAVATION OR CHANGES TO SOIL LEVELS WITHIN 4 METRES OF THE TRUNKS OF TREES TO BE RETAINED ARE NOT PERMITTED UNLESS PART OF THE DEVELOPMENT AS APPROVED, AND THE STORAGE OF SPOIL, BUILDING MATERIALS, SOILS OR THE DRIVING OR PARKING OF ANY VEHICLE OR MACHINERY WITHIN 4 METRES OF THE TRUNK OF A TREE TO BE RETAINED, IS NOT PERMITTED.
- WETTING OF THE SITE SHOULD BE CARRIED OUT AS OFTEN AS NECESSARY AS A FORM OF DUST CONTROL.
- 9. SILT FENCES TO BE CONSTRUCTED WHERE EVER NATURAL SURFACE SLOPES AWAY FROM DISTURBED AREAS OR WHERE DIRECTED BY THE ENGINEER.

EROSON PLAN SCALE: 1:300

# National Engineering Register

Con Katsoulas

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CONSULTANT	No.	AMMENDMENT	DATE	No.	ļ ,	AMMENDMENT	DATE	M
N K ARCHITECT								R
ARCHITECT	2	DA ISSUE - PROVIDE BELOW GROUND TANK	18/02/22					49
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FOR DA APPROVAL

C.K. ENGINEERING SERVICES

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EMAIL: ckatsoulas@gmail.com

CLIENT: DRAWING EROSION

PROJECT:

105 EARNEST STREET, LAKEMBA

EROSION AND SEDIMENT CONTROL PLAN
DRAWING TITLE:

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ESIGNED:	C.K.		(-A) -	SCALE: AS	SHOW		
HECKED:	C.K.		4	DATUM: AHD			
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